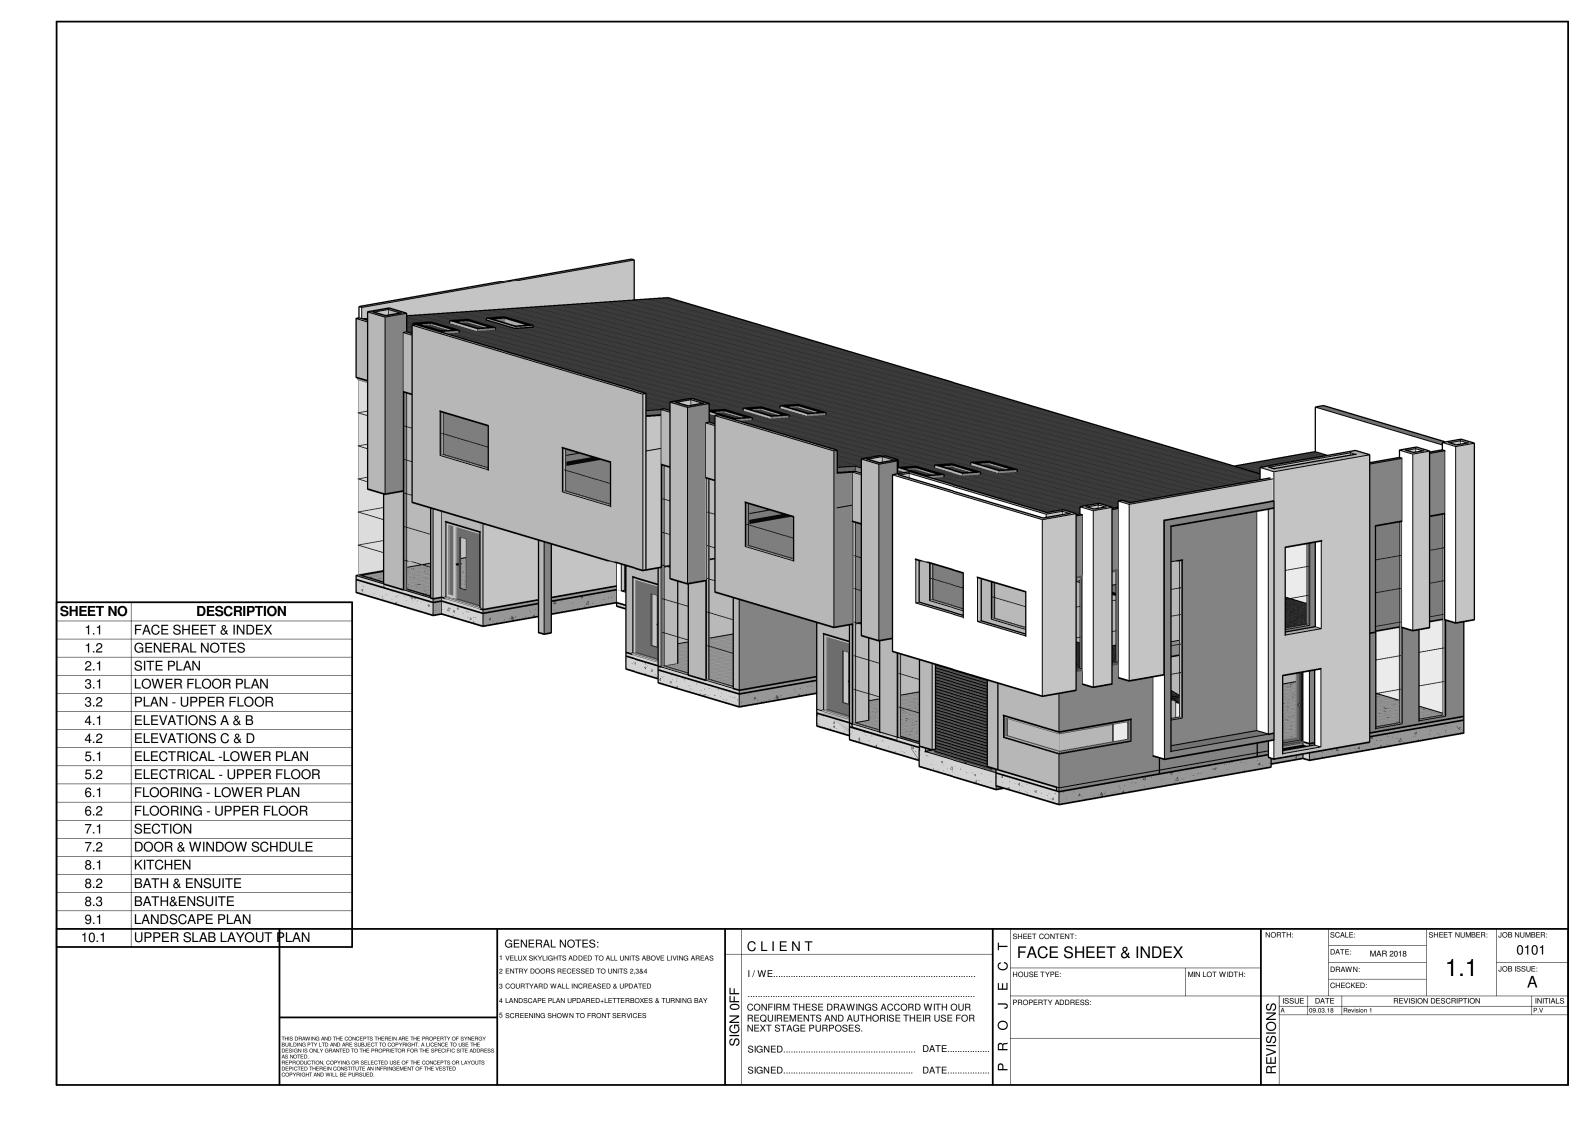
ARCHITECTURAL 2D CONSTRUCTION SET SAMPLES **51 MAJURA AVENUE DICKSON**



GENERAL NOTES.

DO NOT SCALE DRAWINGS. USE WRITTEN DIMENSIONS ONLY.

THE OWNER, BUILDER AND/OR SUB-CONTRACTORS SHALL VERIFY ALL DIMENSIONS, LEVELS, SETBACKS AND ANY SPECIFICATIONS PRIOR TO COMMENCING ANY WORKS OR ORDERING MATERIALS AND SHALL BE RESPONSIBLE FOR ENSURING THAT ALL BUILDING WORKS CONFORM TO THE BUILDING CODE OF AUSTRALIA, AUSTRALIAN STANDARDS CODES (CURRENT EDITIONS), BUILDING REGULATIONS, LOCAL BY-LAWS AND RESCODE REQUIREMENTS, REPORT ALL DISCREPANCIES TO THIS OFFICE FOR CI ARIFICATION

1. THESE PLANS SHALL BE READ IN CONJUNCTION WITH ANY STRUCTURAL OR CIVIL ENGINEERING COMPUTATIONS AND DRAWINGS.

THESE PLANS SHALL BE READ IN CONJUNCTION WITH THE SOIL REPORT. FOOTINGS ARE TO BE FOUNDED AT THE MINIMUM DEPTHS INDICATED I THE SOIL REPORT.

WHERE THE BUILDING (OTHER THAN A CLASS 10a) IS LOCATED IN A DESIGNATED TERMITE INFESTATION AREA THE BUILDING SHALL BE PROTECTED IN ACCORDANCE WITH THE RELEVANT AUSTRALIAN STANDARDS

- 2. STORMWATER SHALL BE TAKEN TO THE LEGAL POINT OF DISCHARGE TO THE SATISFACTION OF THE RELEVANT AUTHORITY.
- SEWER OR SEPTIC SYSTEMS SHALL BE IN ACCORDANCE WITH THE RELEVANT AUTHORITY REQUIREMENTS.
- 4. FOOTINGS ARE NOT TO ENCROACH OVER ANY TITLE BOUNDARIES AND/OR EASEMENT LINES.
- 5. FOR BUILDINGS IN CLOSE PROXIMITY TO THE SEA ENSURE THAT ALL STEEL WORK BRICK CAVITY TIES STEEL LINTELS ETC THAT ARE IMBEDDED OR FIXED TO MASONARY BE PROTECTED IN ACCORDANCE WITH A S 3700-2001 (TABLE 2.2) HOT DIP GALVANIZED, STAINLESS STEEL OR CADMIUM COATED.
- BUILDING SETBACKS ARE FROM TITLE LINE (NOT FENCELINE) REFER TITLE RE-ESTABLISHEMENT PLAN FOR CORRECT OFF SETS IN RELATION TO FENCELINES
- 7. ALL WET AREAS ARE TO COMPLY WITH B.C.A. 3.8.1 OR A.S. 3740-2004. WALL FINISHES SHALL BE IMPERVIOUS TO A HEIGHT OF 1800MM ABOVE FLOOR LEVEL TO ANY SHOWER ENCLOSURES AND 150MM ABOVE BATHS, BASINS, SINKS AND TROUGHS IF WITHIN 75MM OF THE WALL.
- RISERS -190MM MAXIMUM, 115MM MINIMUM. GOING -355MM MAXIMUM, 240MM MINIMUM. RISERS AND TREADS ARE TO BE CONSTANT IN SIZE THRU-OUT FLIGHT, PROVIDE NON-SLIP FINISH OR SUITABLE NON-SKID STRIP NEAR EDGE OF NOSINGS. ENSURE A MAXIMUM GAP BETWEEN RISERS IS NOT TO EXCEED 125MM OR USE CLOSED RISERS.PROVIDE CONTINUOUS HANDRAILING 1000MM MINIMUM HEIGHT TO BALCONIES AND DECKS WHICH ARE 1000MM OR GREATER ABOVE GROUND LEVEL. HANDRAILS ARE TO BE A MINIMUM OF 865MM ABOVE STAIR NOSINGS AND LANDINGS. MAXIMUM GAP BETWEEN BALUSTERS

SHALL BE 125MM

9. SMOKE ALARMS ARE TO BE PROVIDED AND INSTALLED IN ACCORDANCE ROOFING: WITH A.S. 3786-1993, AND UNLESS INSTALLED IN AN EXISTING PART OF A CLASS 1, 2 OR 3 BUILDING OR A CLASS 4 PART OF A BUILDING THE CONCRETE TILED ROOF OVER ROOF BATTENS AT 330 CTRS. TYPICAL SMOKE ALARM SHALL BE HARD-WIRED WITH A BATTERY BACK-UP INTERCONNECTED.

BRICKWORK:

PROVIDE WALL-TIES TO BRICKWORK AT A MAXIMUM OF 600MM IN EACH DIRECTION AND WITHIN 300MM OF ANY ARTICULATION JOINTS. FOR PERPS AND BEDS JOINTS SPACINGS (REFER TO BCA PART 331)

SPECIFICATION NOTES:

TIMBER FRAMING:

ALL TIMBER FRAMING THRU-OUT IS TO BE IN ACCORDANCE WITH A.S. 1684 AND ALSO READ IN CONJUNCTION WITH THE ENGINEERS DETAILS AND DRAWINGS.

FLOORING & FOOTINGS:

FINISHED FLOOR LEVELS ARE NOMINAL ONLY AND SHOULD BE CONFIRMED PRIOR TO START OF WORK

READ IN ACCORDANCE WITH THE SOIL REPORT REQUIREMENTS. READ IN CONJUNCTION WITH THE ENGINEERS DETAILS FOR ALL FOOTING SIZE &

PLEASE NOTE MINIMUM FOUNDING DEPTH TO BE DETERMINED AS "NOTED" IN THE SOIL REPORT

WALL LINTELS & SUPPORT STUDS THRU-OUT:

FOR ALL EXTERNAL PERIMETER LOAD-BEARING LINTELS AND THEIR SUPPORTING STUDS REFER TO THE ENGINEERS DETAILS AND DRAWINGS AND TO GENERAL SPECIFICATIONS

INTERNAL DOORS:

ALL INTERNAL DOORS ARE TO BE 2040mm HIGH UNLESS NOTED OTHERWISE ON THE PLAN.

WC DOORS:

HINGED DOORS THAT OPEN INWARDS TOWARDS THE PAN BUT THE EDGE OF THE DOOR IS A MINIMUM OF 1200MM AWAY FROM THE PAN AT ITS NEAREST POINT MUST HAVE DEMOUNTABLE HINGES TO ALLOW EASY REMOVAL OF THE DOOR FROM THE OUTSIDE THE WC COMPARTMENT

THRU-OUT UNLESS NOTED OTHERWISE.

METAL EITHER TIMBER OR METAL BATTENS TO BE USED & FIXED IN ACCORDANCE WITH THE MANUFACTURERS DETAILS & SPECIFICATIONS & PROVIDE APPROVED CAPPING & FLASHING THRU-OUT.

SELECTED TIMBER FRAMED ROOF TRUSS AT 600mm MAX CTRS. TO MANUFACTURERS SPECIFICAIONS UNESS NOTED OTHERWISE

PLASTERBOARD LINED CEILINGS THRU-OUT.

SELECTED PROFILE METAL EAVES GUTTER & FASCIA TO THE PERIMETER OF THE ROOF AREA

ALSO READ IN CONJUNCTION WITH ANY ENGINEERS DETAILS & DRAWINGS FOR ANY ROOF BEAMS, LINTELS, ETC.

4.5mm THICK F.C. SHEET CEILING LINING TO THE UNDERSIDE OF THE FIRST FLOOR EAVES.

LINTEL NOTES:

BUILDER IS TO NOTE THAT LINTELS SELECTED BY THE ENGINEER ARE DESIGNED TO CARRY ONLY STANDARD TILE ROOFING & TRUSS LOADS WHERE ARE AT 600mm MAXIMUM CTRS. IF ANY GIRDER TRUSSES ARE LOCATED DIRECTLY ON ANY LINTELS

TRUSS MANUFACTURER AND / OR BUILDER IS TO REFER TO THE ENGINEER TO CONFIRM IF LINTEL & SUPPORTING STUDS ARE ADEQATE.

ENGINEER'S DRAWINGS TAKE PRECEDENCE OVER NOMINAL SIZES INDICATED ON THESE PLANS

WINDOWS:

ALL GLAZING SHALL CONFORM TO AS1288-2006. WINDOW SIZES SHOWN ARE NOMINAL DEPENDING ON THE WINDOW MANUFACTURERS CLOSEST STANDARD SPECIFICAIONS.

- ALL GLAZING IS TO BE IN ACCORDANCE WITH AS1228-2006.
- 2. READ IN CONJUNCTION WITH THE WINDOW SCHEDULE & ELEVATIONS.
- 3. ALL EXTERNAL DOORS ARE TO FITTED WITH WEATHER STRIPS.
- 4 'E' DENOTES FIXED GLAZING 'D' DENOTES OPENABLE SASH

NOTE: THESE HEIGHTS MAY VARY SLIGHTLY ACCORDING TO DIFFERENCES IN BRICK SIZES.

WALLING:

90mm WIDE STUD FRAME WALLS THRU-OUT MGP10 GRADE 90x35 COMMON STUDS

70x35 NOGGINGS 2(90x35) TOP PLATES 2(90x45) JAMB STUDS

LININGS:

10mm PLASTERBOARD TO ALL INTERNAL WALLS. 10mm PLASTERBOARD TO CEILINGS. SELECTED WATER RESISTANT SUB-STRATE & TILING TO WE AREAS.

HEATING & COOLING:

ALL HEATING & COOLING UNITS, SIZES, TYPES & LOCATIONS ARE TO BE CONFIRMED BETWEEN THE BUILDER & THE SUPPLIER.

ALL HEATING & COOLING DUCTS & VENT LOCATIONS ARE TO BE CONFIRMED BY THE BUILDER PRIOR TO COMMENCEMENT OF BUILDING TO DETERMINE IF ANY ADDITIONAL RISER DUCTS ARE REQUIRED.

ALL HEATING & COOLING POINTS LOCATIONS MAY VARY FROM PLAN TO PLAN.

GEOTECHNICAL:

THESE DRAWINGS ARE TO BE READ IN CONJUNCTION WITH A GEOTECHNICAL REPORT. IT IS THE BUILDERS'S RESPONSIBILITY TO OBTAIN SUCH REPORTS PRIOR TO COMMENCEMENT OF WORKS.

FULL HEIGHT CONTROL JOINTS (FOOTING TO EAVES) AT 5m MAX CTRS UNLESS OTHERWISE STATED IN THE SOIL REPORT

REFER TO SOIL REPORT.

6 STAR ENERGY UPGRADE:

- 1. ALL EXTERNAL GAPS & CRACKS TO WINDOW/DOOR FRAMES SEALED ON CONSTRUCTION.
- SISALATION APPLIED TO ALL WALLS. & GAPS/JOINS SEALED. 3. SELF CLOSING EXHAUST FANS THROUGHOUT OR 'DRAFT
- 4. WEATHER STRIPS/SEALS TO ALL EXTERNAL HINGED DOORS AND INTERNAL GARAGE ACCESS DOOR
- 5 ALL CHIMNEYS FITTED WITH DAMPERS

SHEET CONTENT

6. ALL DOWNLIGHTS OF "CLOSED-RING" TYPE

STOPPER' SHROUDS OVER EXHAUST FANS.

7. INSULATION LEVELS AS DETAILED IN ATTACHED ENERGY RATING ASSESSOR'S REPORT

| LINTEL SCHEDULE | | | |
|-----------------|--------------------------------|--------------------------------|--|
| | UPPER FLOOR & SINGLE STOREY | LOWER FLOOR (DOUBLE STOREY) | |
| MEMBER SIZE | MAX SIZE OF OPENING (mm) | MAX SIZE OF OPENING (mm) | |
| 90x45 F17 KDHW | 1000 | 800 | |
| 140x45 F17 KDHW | 1400 | 1200 | |
| 190x45 F17 KDHW | 1900 | 1600 | |
| 240x45 F17 KDHW | 2400 | 2000 | |
| 290x45 F17 KDHW | 2900 | 2400 | |
| 190x45 F17 KDHW | 1900 | 1600 | |
| 90x45 F17 KDHW | 1000 FRONT DOOR | 800 | |
| 90x45 F17 KDHW | 900 GARAGE REAR DOOR | 800 | |
| | | | |

| SOIL CLASSIFICATION: "X" | | | |
|--------------------------|------------|--|--|
| REPORT NO: | S00000 | | |
| BY: | FMG | | |
| DATE: | 00/00/2015 | | |
| B.A.L.: | XX | | |
| WIND SPEED: | N-X | | |

| WALLING | FRAME SIZES |
|----------------|-------------|
| EXTERNAL STUDS | 600mm |
| INTERNAL STUDS | 600mm |

| ENERGY REPO | ORT - INSULATION |
|--------------------------------------------|-------------------------------------------|
| INSULATION TO BE INS AREAS: | TALLED TO THE FOLLOWING |
| CEILINGS | R 2.5 |
| WALLS | R 1.5 + SISALATION |
| REQUIREMENTS ARE AS PENDING ENERGY REPO | S PER STANDARD INCLUSION DRT – REF NO# |

NORTH

GENERAL NOTES:

VELUX SKYLIGHTS ADDED TO ALL UNITS ABOVE LIVING AREAS ENTRY DOORS RECESSED TO UNITS 2,3&4

COURTYARD WALL INCREASED & UPDATED

LANDSCAPE PLAN UPDARED+LETTERBOXES & TURNING BAY SCREENING SHOWN TO FRONT SERVICES

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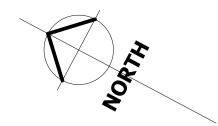
CLIENT CONFIRM THESE DRAWINGS ACCORD WITH OUR REQUIREMENTS AND AUTHORISE THEIR USE FOR **NEXT STAGE PURPOSES** SIGNED. DATE SIGNED. DATE.

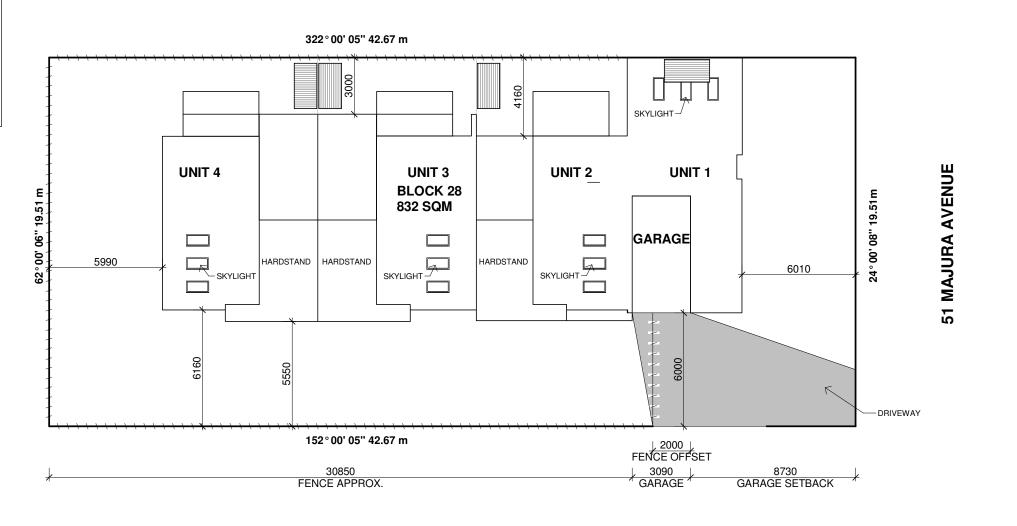
GENERAL NOTES MIN LOT WIDTH: HOUSE TYPE: PROPERTY ADDRESS CLIENT

SCALE: SHEET NUMBER: JOB NUMBER 0101 DATE: MAR 2018 1.2 DRAWN JOB ISSUE: Α CHECKED REVISION DESCRIPTION INITIALS ISSUE DATE

NOTE: ENVIRONMENTAL PROTECTION GUIDELINES - RESIDENTIAL BLOCKS

- MAINTAIN AS MANY GRASSED AREA AS POSSIBLE PARTICULARLY ON THE VERGES TO TRAP SOIL BEFORE IT REACHES THE ROADWAY AND STORMWATER SYSTEM. FENCE OFF UNDISTURBED AREAS
- USE ONLY ONE EXIT/ENTRY TO THE SITE BUILD A STABILISED ACCESS POINT BY USING ROAD BASE,50mm AGGREGATE, RECYCLED CONCRETE OR SIMILAR
- ASSIGN DESIGNATED PARKING AREA
- LIMIT ACCESS TO THE SITE DURING AND IMMEDIATELY AFTER WET WEATHER
- KEEP STOCKPILE WITHIN THE SITE AREA AND AWAY FROM THE STORMWATER SYSTEM
- INSTALL A SEDIMENT CONTROL BARRIER OF GEO TEXTILE FABRIC ON THE LOWSIDE/S OF THE BLOCK
- DESIGNATE A BRICK CUTTING AND WASH AREA AWAY FROM STORMWATER DRAINS.
- ENSURE THE AREA IS LARGE ENOUGH TO CONTAIN ALL EXCESS WATER, RESIDUESAND WASTE.
- REGULARLY CHECK AND MAINTAIN POLLUTION CONTROLS THROUGHOUT CONSTRUCTION (REFER ENVIRONMENT PROTESTATION)
- (REFER ENVIRONMENT PROTESTATION GUIDELINES FOR CONSTRUCTION & LAND DEVELOPMENT IN ACT)





LEGEND Ð - GAS METER HOT WATER SYSTEM METER BOX - TITLE PEG - SEWER VENT / I.S. T - TELSTRA PIT - TREE Ħ - STREET SIGN - SEWER MANHOLE 0 - ELECT. PIT Ω - ELEC. POLE SEP - SIDE ENTRY PIT - WATER VALVE - S/W PROPERTY INLET M - WATER METER Т - STORM WATER PIT - TBM - HABITABLE ROOM WINDOW - SIGN STAMPED ON CONCRETE KERB - NON-HABITABLE ROOM WINDOW - PRIVATE OPEN SPACE - POWERLINES EE - PROPOSED FENCE - EXISTING FENCE 0 0 - SEWER PIPE - STORM WATER PIPE - EASEMENT - SILT PIT - AG DRAIN - RETAINING WALL **TOTAL HOUSE AREA TOTAL HOUSE AREA** 539.51 m² SITE AREA 832 m² SITE COVERAGE 64.84 %

00.00 m²

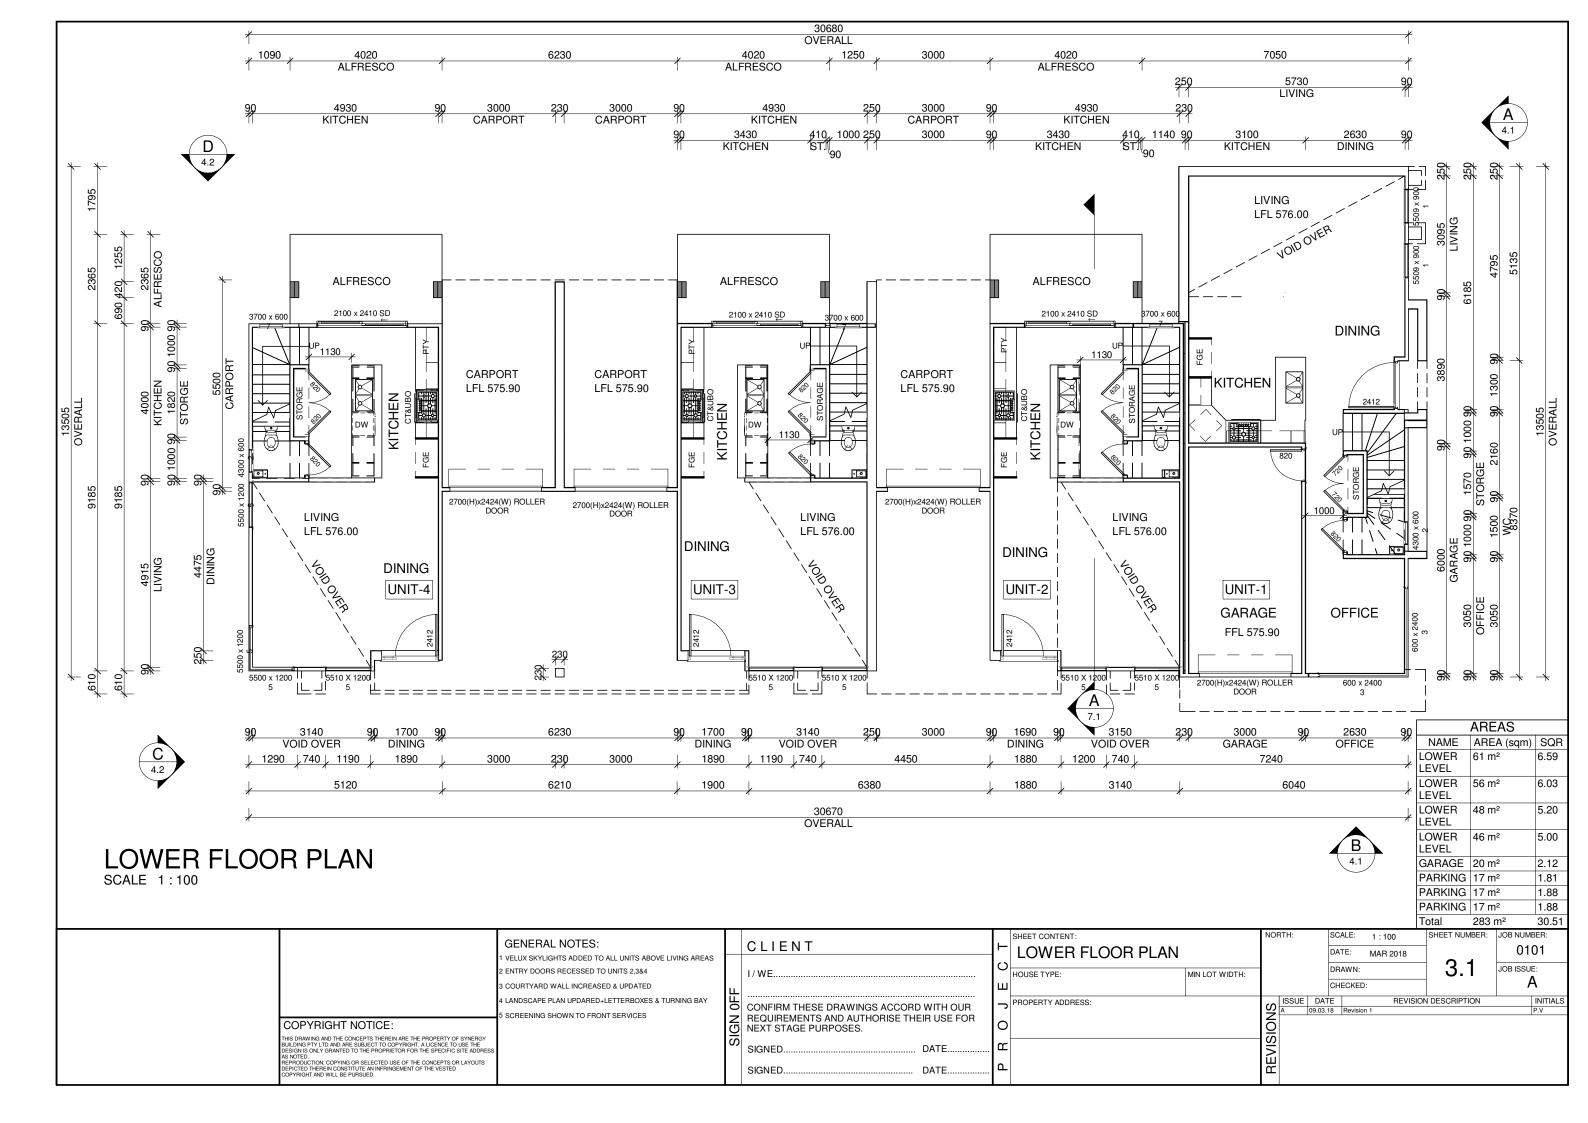
32.39 %

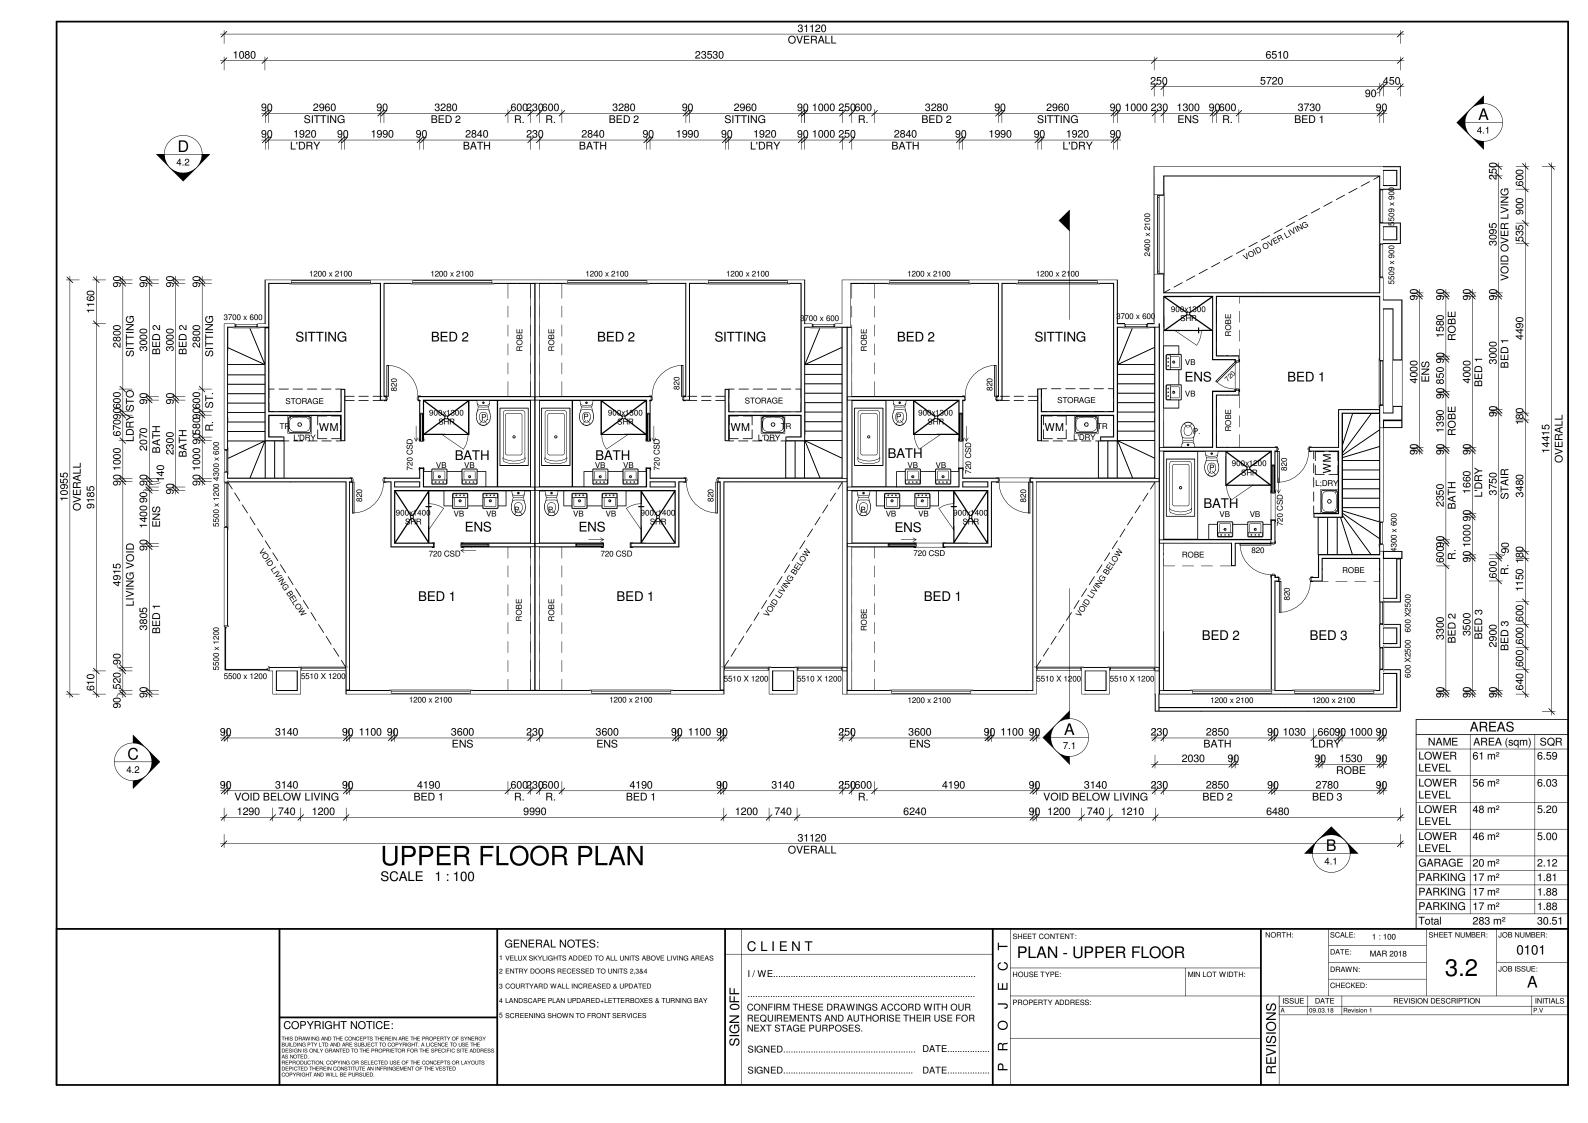
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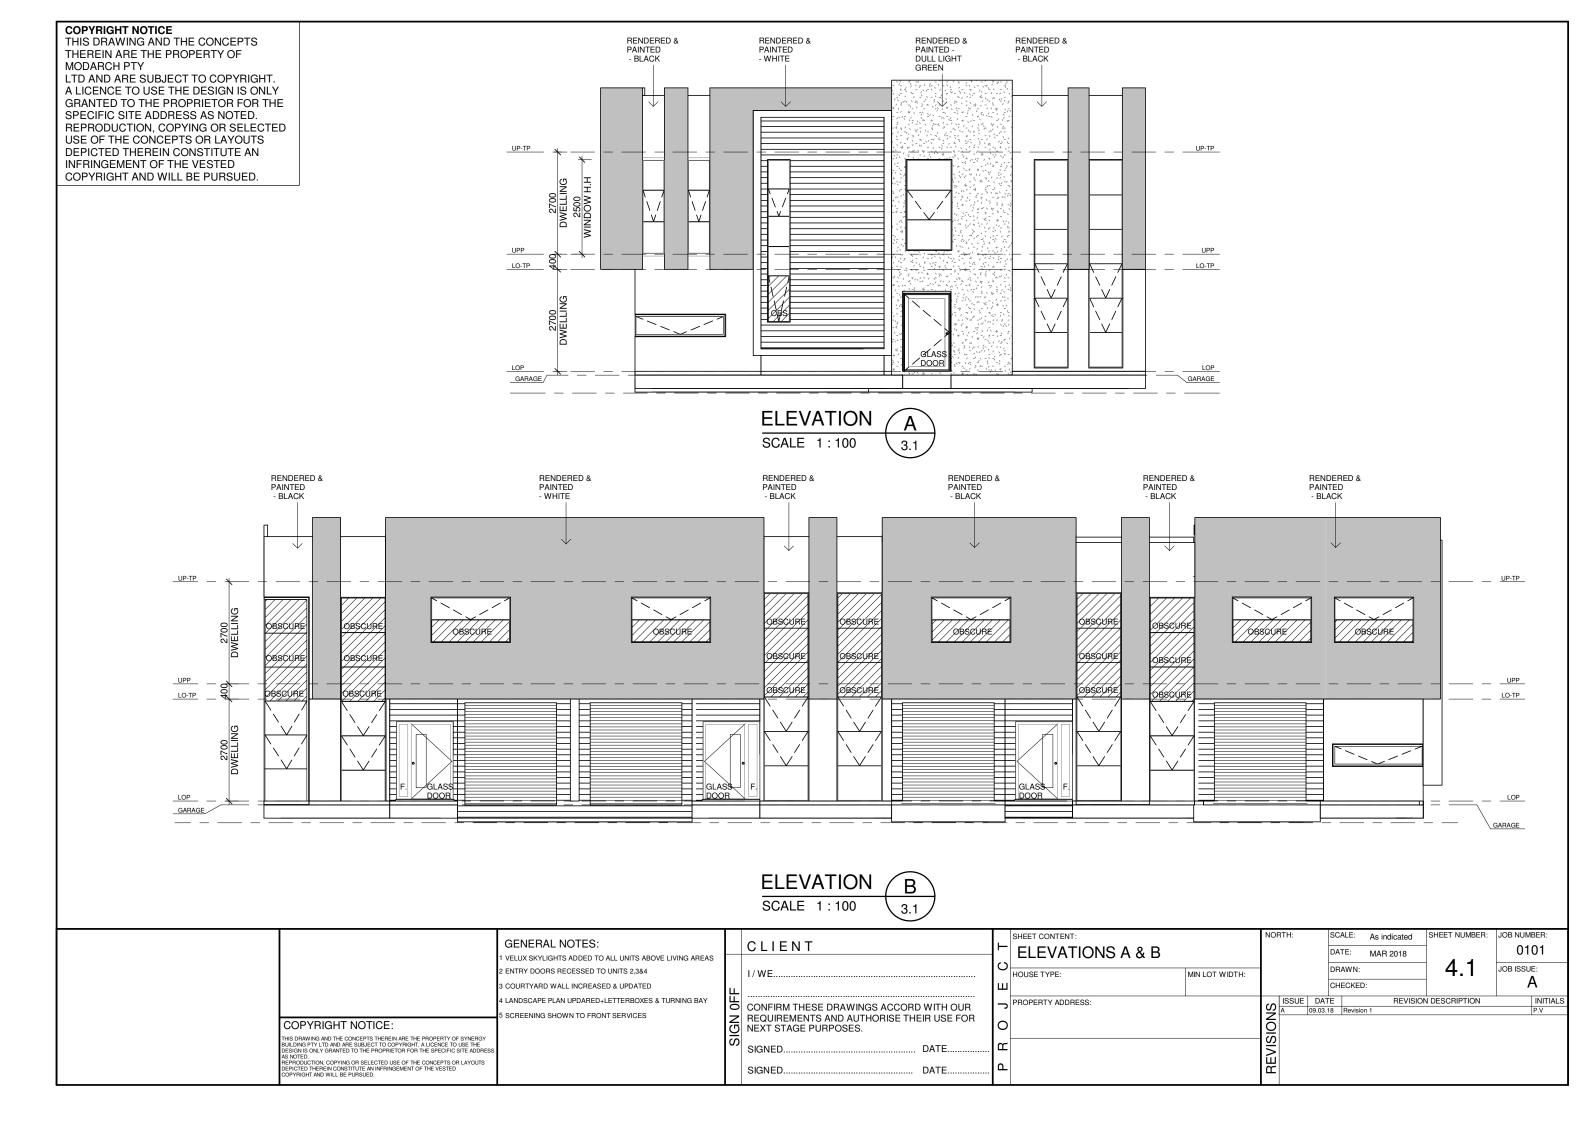
PERMEABLE COVERAGE

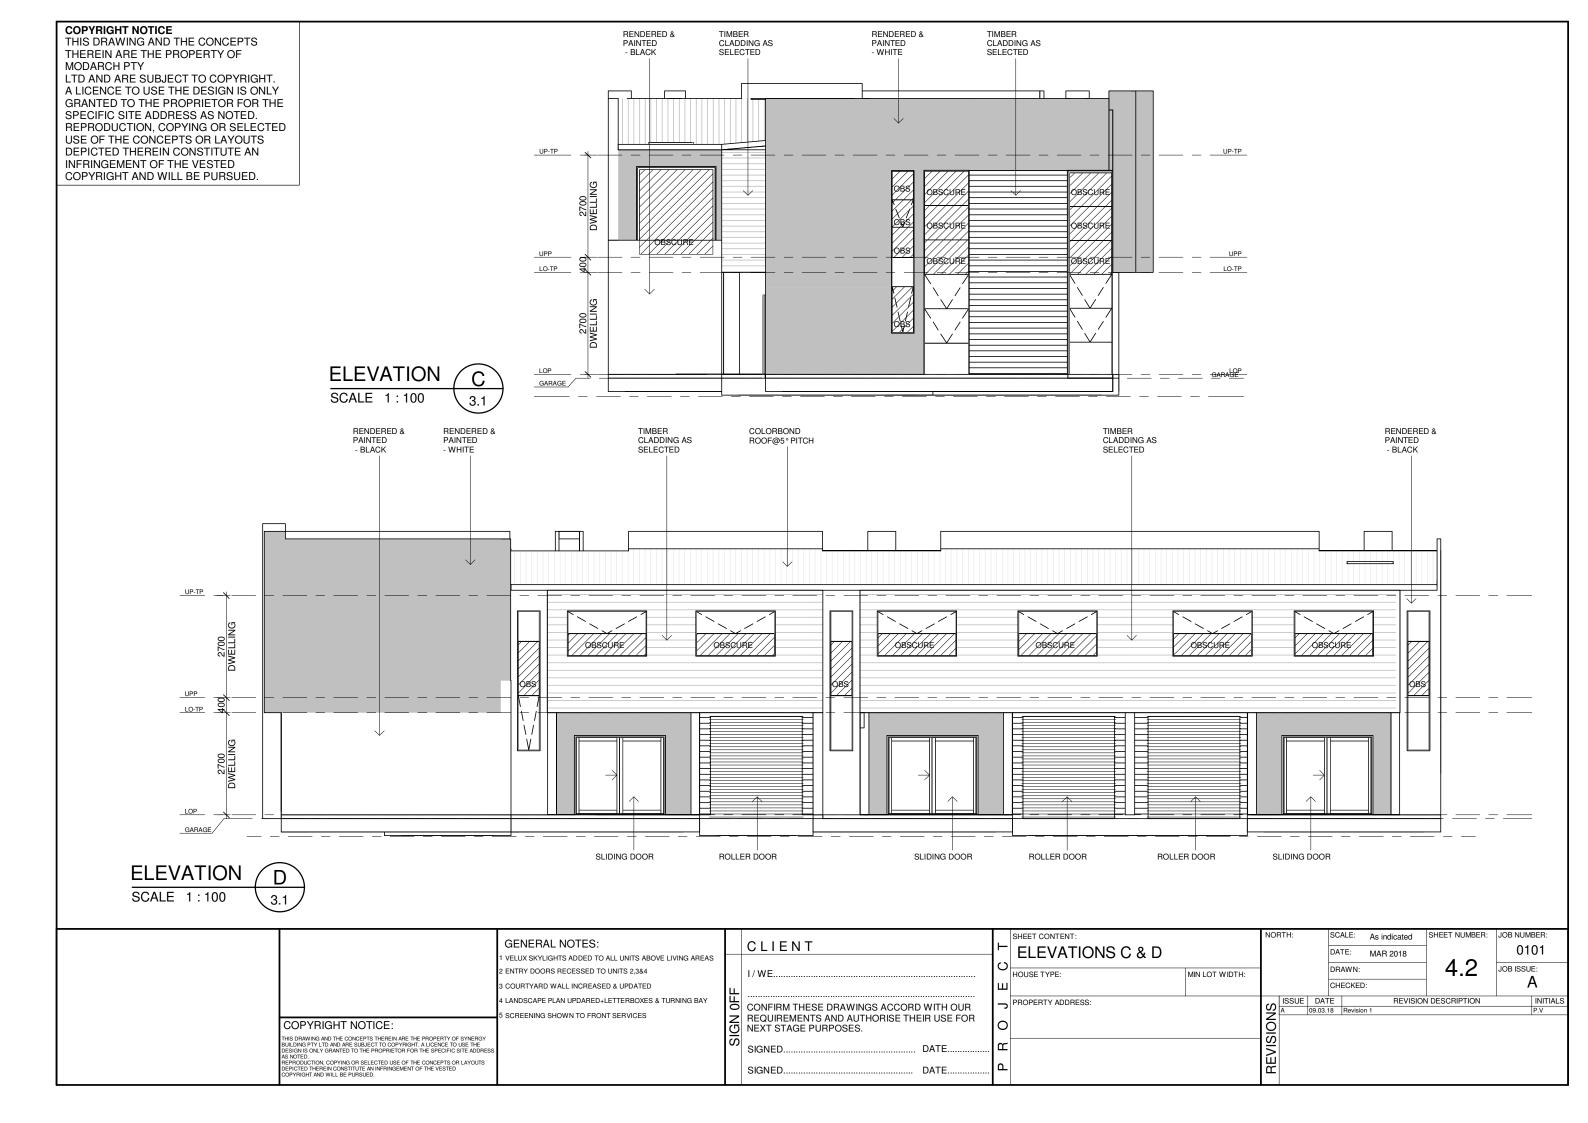
SITE PLAN SCALE 1:200

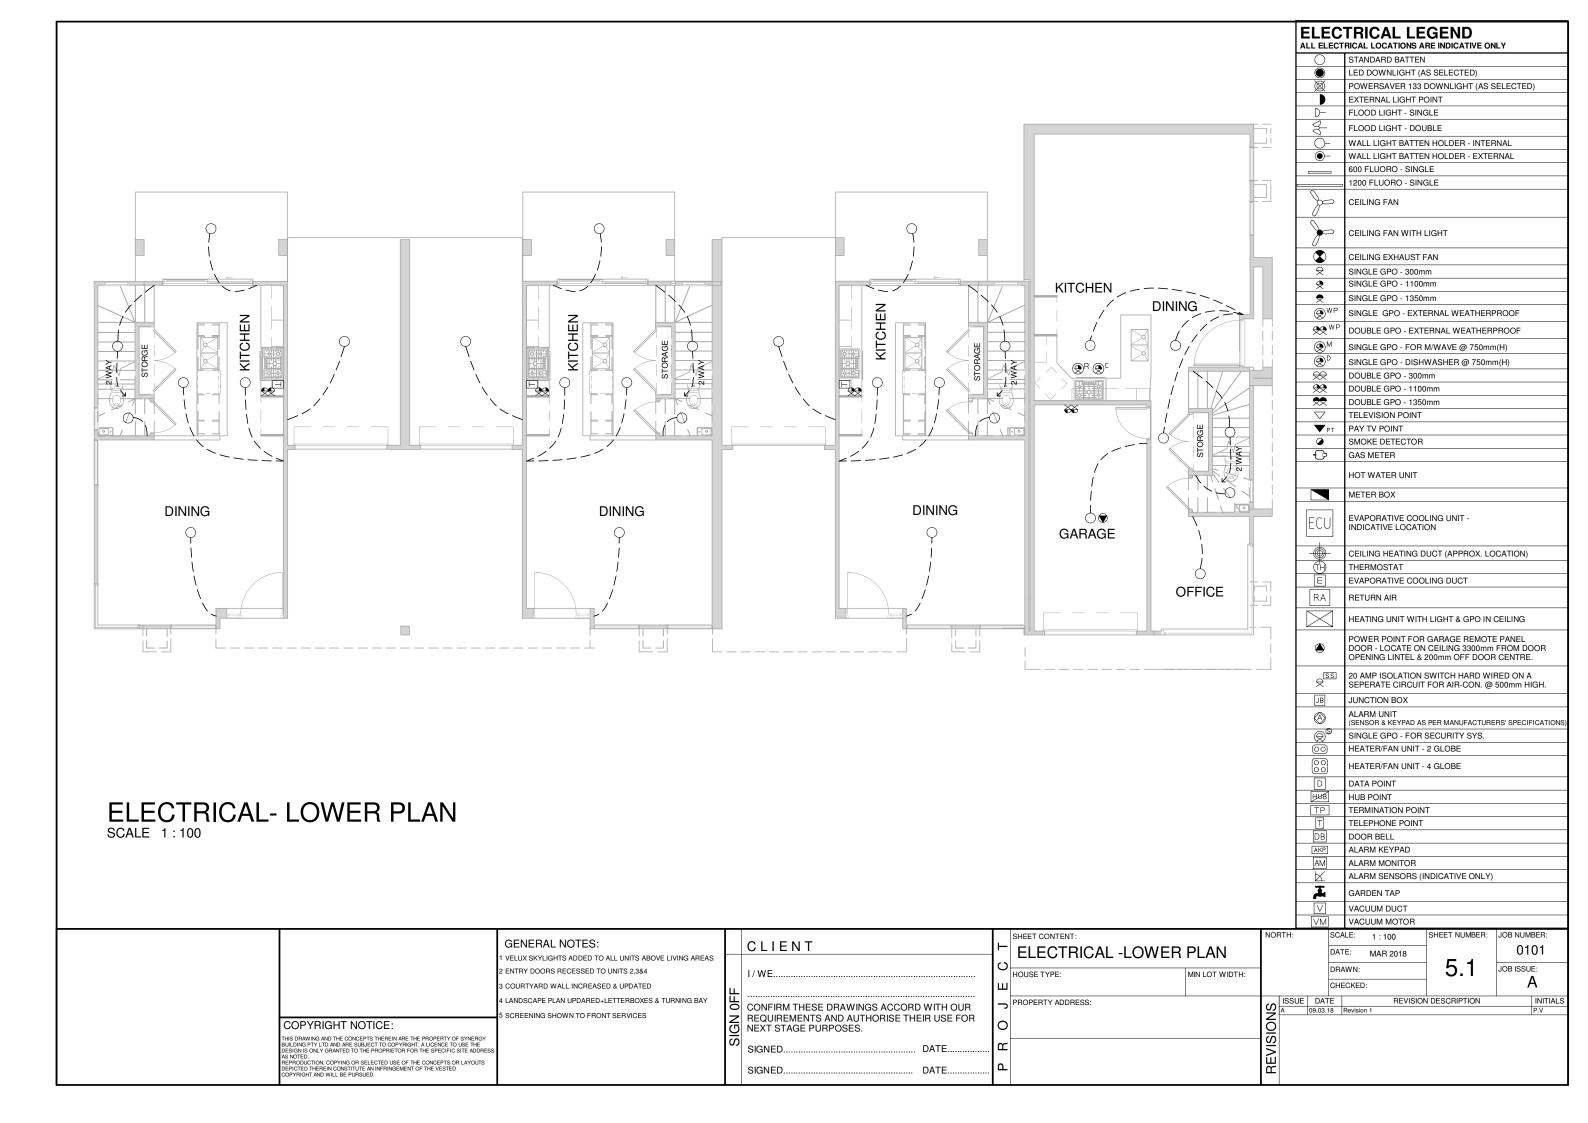
SHEET CONTENT: NORTH SCALE: SHEET NUMBER: JOB NUMBER As indicated **GENERAL NOTES:** CLIENT 0101 SITE PLAN DATE: MAR 2018 VELUX SKYLIGHTS ADDED TO ALL UNITS ABOVE LIVING AREAS JOB ISSUE: ENTRY DOORS RECESSED TO UNITS 2,3&4 DRAWN MIN LOT WIDTH: HOUSE TYPE: Α CHECKED: COURTYARD WALL INCREASED & UPDATED LANDSCAPE PLAN UPDARED+LETTERBOXES & TURNING BAY REVISION DESCRIPTION INITIALS PROPERTY ADDRESS CONFIRM THESE DRAWINGS ACCORD WITH OUR REQUIREMENTS AND AUTHORISE THEIR USE FOR SCREENING SHOWN TO FRONT SERVICES COPYRIGHT NOTICE: NEXT STAGE PURPOSES. THIS DRAWING AND THE CONCEPTS THEREIN ARE THE PROPERTY OF SYNERGY SUILDING PTY LTD AND ARE SUBJECT TO COPYRIGHT. A LICENCE TO USE THE DESIGN IS ONLY GRANTED TO THE PROPRIETOR FOR THE SPECIFIC SITE ADDRE SIGNED. DATE. S NOTED. EPRODUCTION, COPYING OR SELECTED USE OF THE CONCEPTS OR LAYOUTS EPICTED THEREIN CONSTITUTE AN INFRINGEMENT OF THE VESTED OPYRIGHT AND WILL BE PURSUED. SIGNED. DATE.

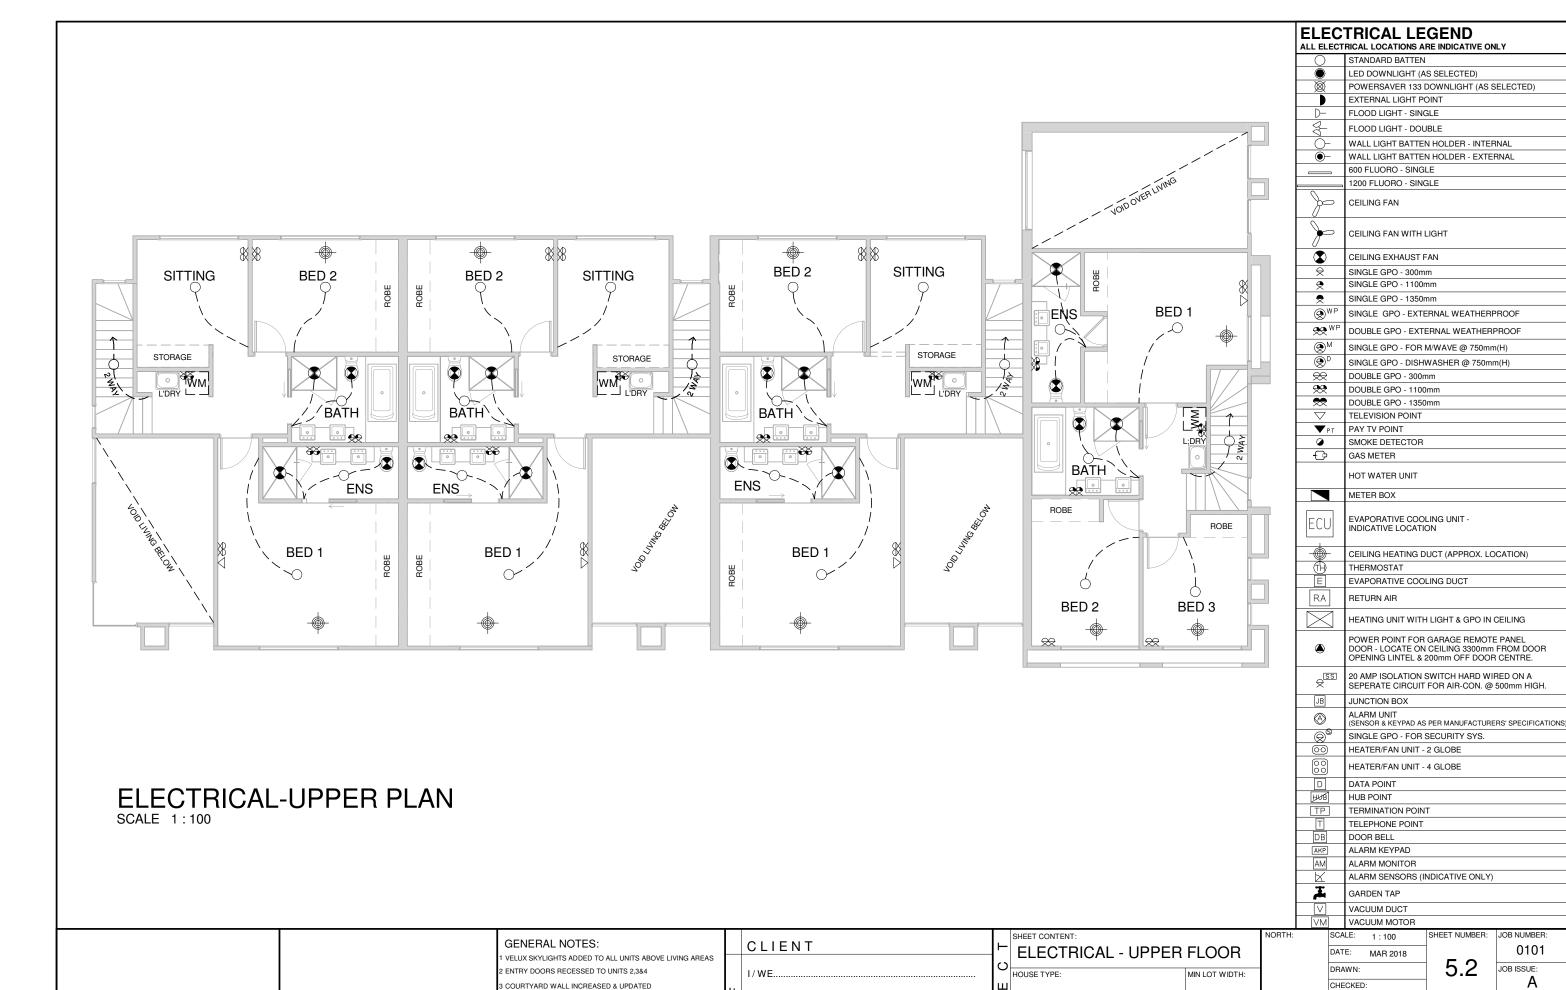












CONFIRM THESE DRAWINGS ACCORD WITH OUR

NEXT STAGE PURPOSES.

SIGNED..

SIGNED..

REQUIREMENTS AND AUTHORISE THEIR USE FOR

DATE.

DATE.

| ISSUE | DATE | A | 09.03.18 | 09.03.18 |

PROPERTY ADDRESS:

INITIALS P.V

REVISION DESCRIPTION

3 COURTYARD WALL INCREASED & UPDATED

SCREENING SHOWN TO FRONT SERVICES

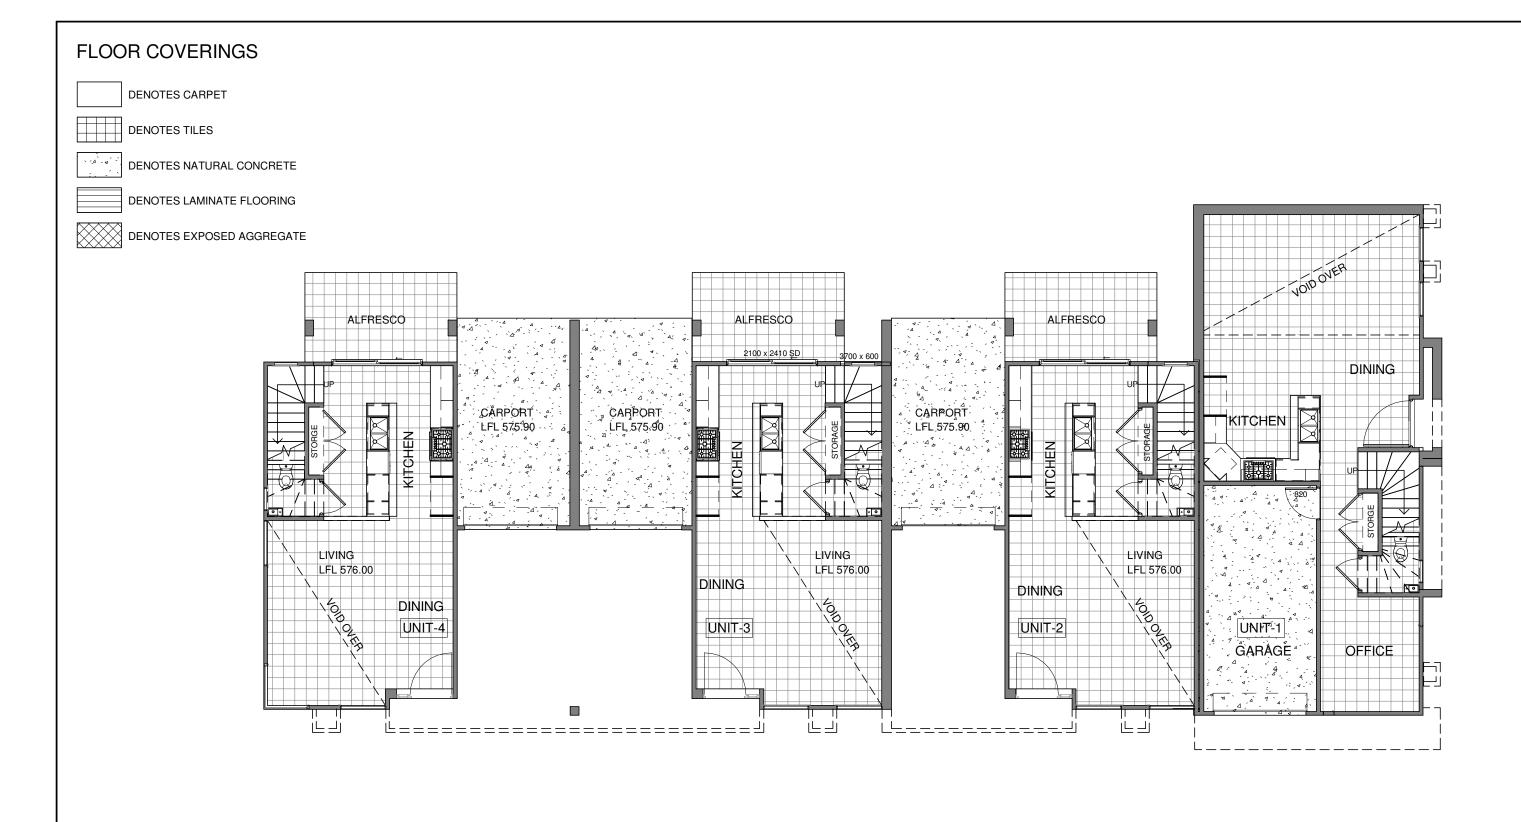
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LANDSCAPE PLAN UPDARED+LETTERBOXES & TURNING BAY



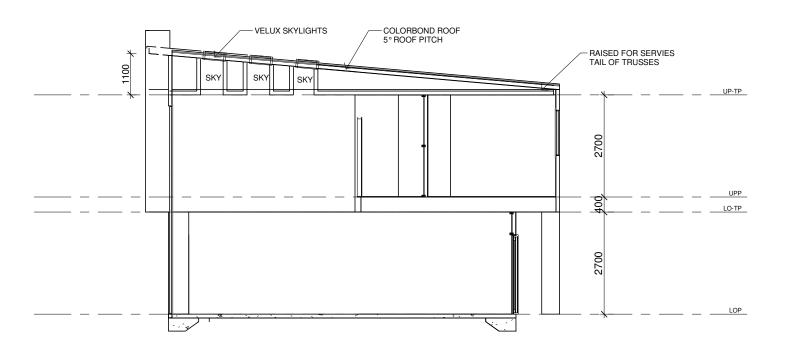
FLOORING - LOWER PLAN

SCALE 1:100 SHEET CONTENT: SCALE: SHEET NUMBER: JOB NUMBER **GENERAL NOTES:** CLIENT 0101 FLOORING - LOWER PLAN DATE: MAR 2018 VELUX SKYLIGHTS ADDED TO ALL UNITS ABOVE LIVING AREAS 6.1 DRAWN: JOB ISSUE: ENTRY DOORS RECESSED TO UNITS 2,3&4 HOUSE TYPE: Α COURTYARD WALL INCREASED & UPDATED SISSUE DATE
A 09.03.18 INITIALS P.V LANDSCAPE PLAN UPDARED+LETTERBOXES & TURNING BAY REVISION DESCRIPTION PROPERTY ADDRESS: CONFIRM THESE DRAWINGS ACCORD WITH OUR REQUIREMENTS AND AUTHORISE THEIR USE FOR NEXT STAGE PURPOSES. SCREENING SHOWN TO FRONT SERVICES COPYRIGHT NOTICE: HIS DRAWING AND THE CONCEPTS THEREIN ARE THE PROPERTY OF SYNERGY IUILDING PTY LTD AND ARE SUBJECT TO COPYRIGHT. A LICENCE TO USE THE ESIGM IS ONLY GRANTED TO THE PROPRIETOR FOR THE SPECIFIC SITE ADDR SIGNED. DATE.



FLOORING - UPPER PLAN SCALE 1:100

SHEET CONTENT: SCALE: SHEET NUMBER: JOB NUMBER 1:100 **GENERAL NOTES:** CLIENT 0101 FLOORING - UPPER FLOOR DATE: MAR 2018 VELUX SKYLIGHTS ADDED TO ALL UNITS ABOVE LIVING AREAS 6.2 DRAWN: JOB ISSUE: ENTRY DOORS RECESSED TO UNITS 2,3&4 HOUSE TYPE: Α COURTYARD WALL INCREASED & UPDATED CHECKED: SISSUE DATE A 09.03.18 F INITIALS P.V LANDSCAPE PLAN UPDARED+LETTERBOXES & TURNING BAY REVISION DESCRIPTION PROPERTY ADDRESS: CONFIRM THESE DRAWINGS ACCORD WITH OUR REQUIREMENTS AND AUTHORISE THEIR USE FOR NEXT STAGE PURPOSES. SCREENING SHOWN TO FRONT SERVICES COPYRIGHT NOTICE: THIS DRAWING AND THE CONCEPTS THEREIN ARE THE PROPERTY OF SYNERGY BUILDING PTY LTD AND ARE SUBJECT TO COPYRIGHT. A LICENCE TO USE THE DESIGN IS ONLY GRANTED TO THE PROPRIETOR FOR THE SPECIFIC SITE ADDRI SIGNED. DATE.. ESIGN IS UNET GRAVITED TO THE FIRST THE CONCEPTS OR LAYOUTS IEPRODUCTION, COPYING OR SELECTED USE OF THE CONCEPTS OR LAYOUTS SEPICITED THEREIN CONSTITUTE AN INFRINGEMENT OF THE VESTED COPYRIGHT AND WILL BE PURSUED. SIGNED.. DATE.



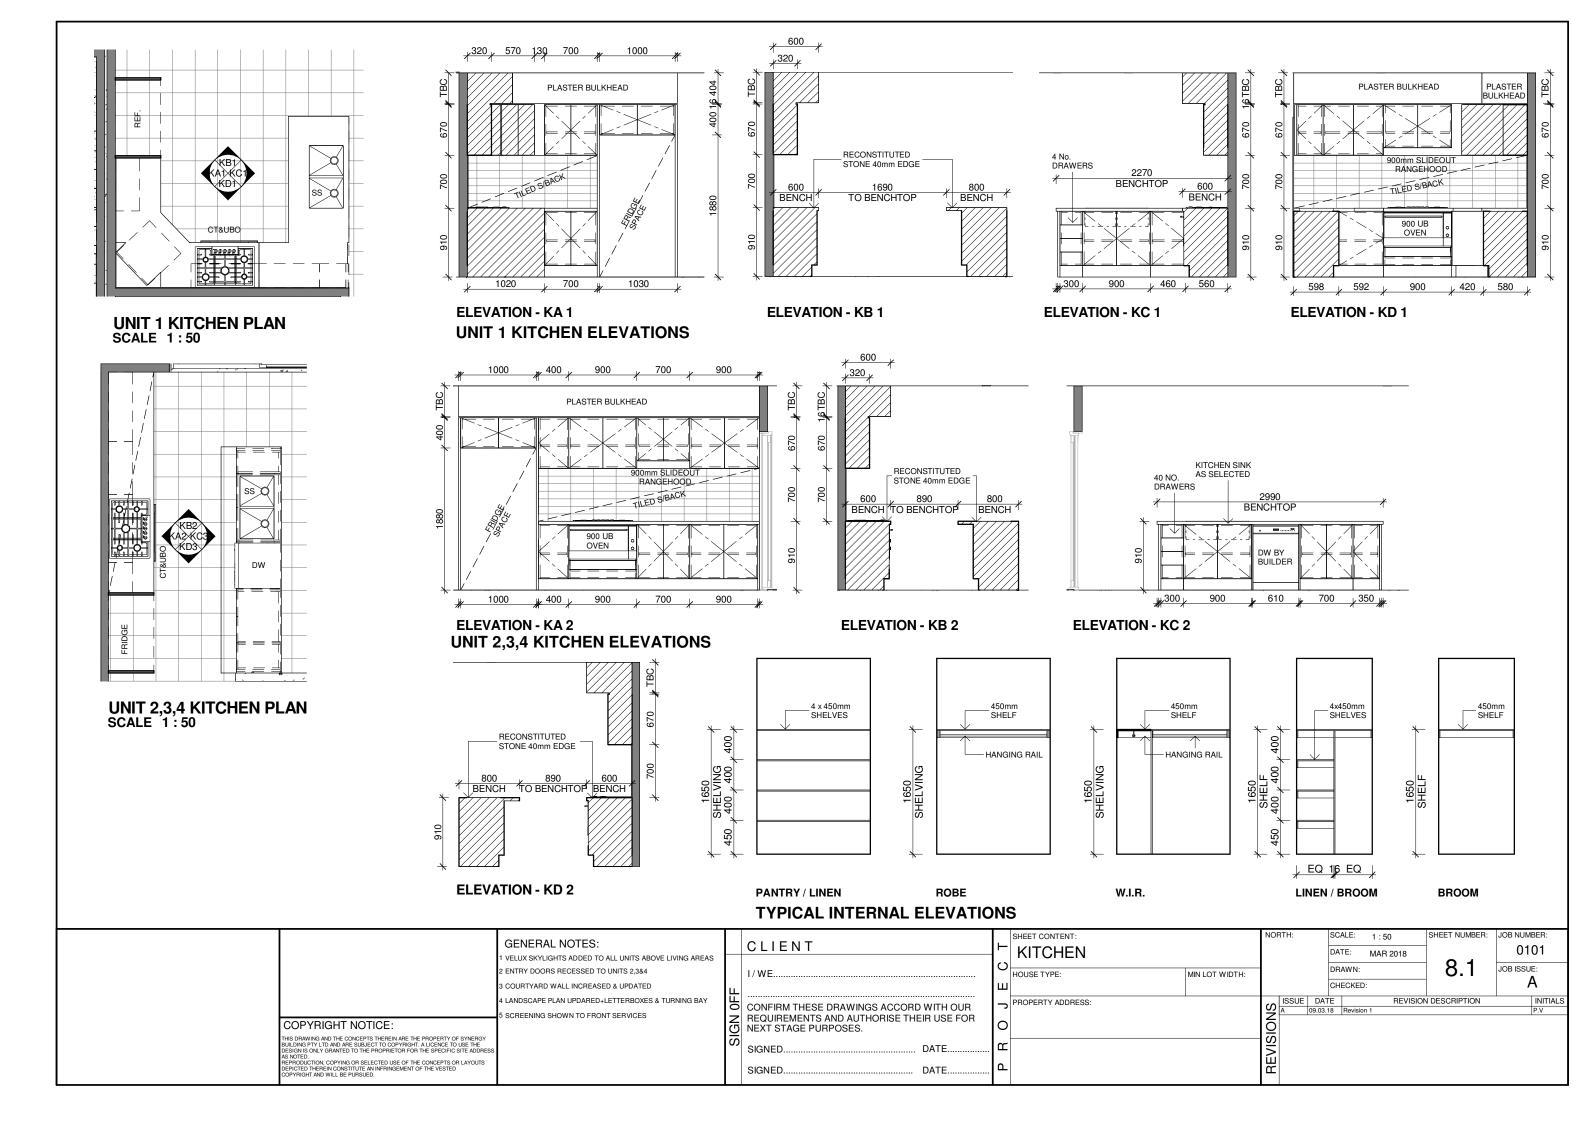
SECTION A

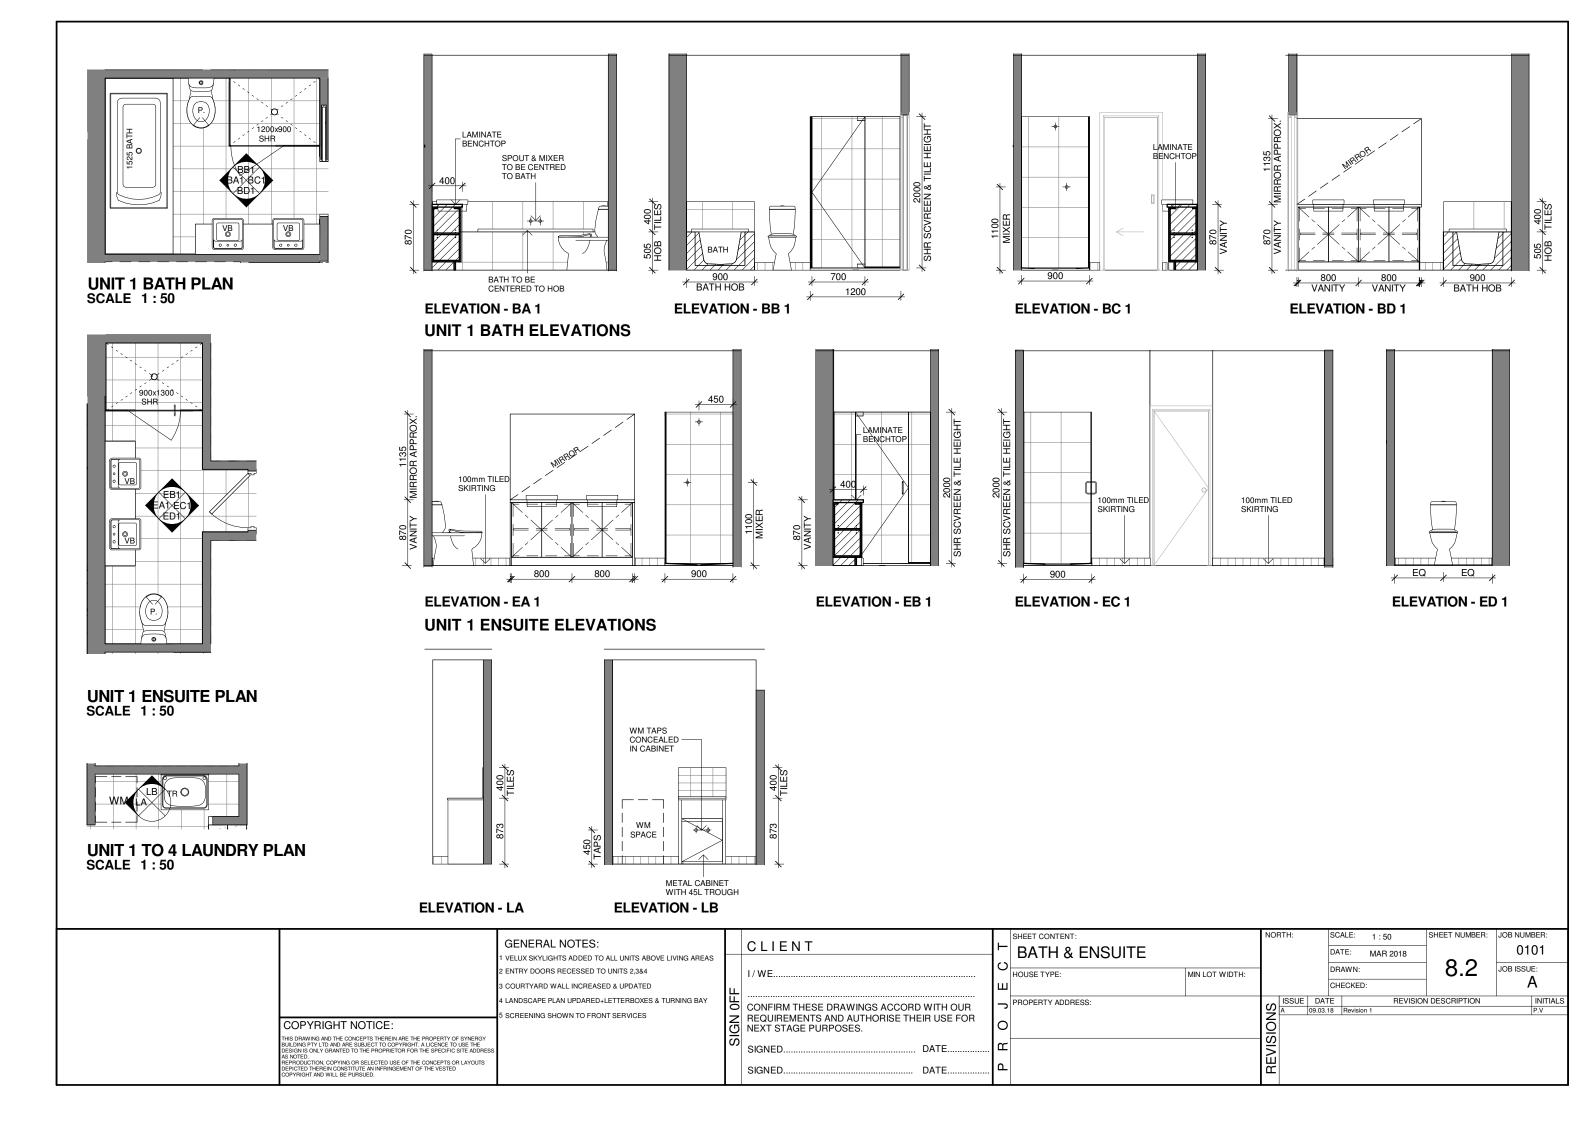
| GENERAL NOTES: 1 VELUX SKYLIGHTS ADDED TO ALL UNITS ABOVE LIVING AREAS 2 ENTRY DOORS RECESSED TO UNITS 2,3&4 3 COURTYARD WALL INCREASED & UPDATED 4 LANDSCAPE PLAN UPDARED+LETTERBOXES & TURNING BAY 5 SCREENING SHOWN TO FRONT SERVICES THIS DRAWING AND THE CONCEPTS THEREIN ARE THE PROPERTY OF SYNERGY BUILDING PTY LTD AND ARE SUBJECT TO COPYRIGHT, A LICENCE TO USE THE DESIGNS ONLY GRANTED TO THE PROPRIETOR FOR THE SPECIFIC SITE ADDRESS AS NOTED. AS NOTED. BENCH TO THE CONCEPTS OR LAYOUTS GENERAL NOTES. GENERAL NOTES. COPYRIGHT AND WILL BE PURSUED. | CLIENT I/WE CONFIRM THESE DRAWINGS ACCORD WITH OUR REQUIREMENTS AND AUTHORISE THEIR USE FOR NEXT STAGE PURPOSES. SIGNED | SHEET CONTENT: SECTION HOUSE TYPE: MIN LOT WIDTH: PROPERTY ADDRESS: O C | NORTH: SCALE: 1:100 DATE: MAR 2018 DRAWN: CHECKED: SHEET NUMBER: 0101 T.1 JOB NUMBER: 0101 JOB ISSUE: INITIALS |
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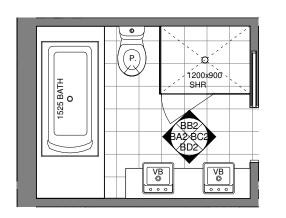
| Window Schedule | | | |
|-----------------|--------|-------|--|
| Mark | Height | Width | |
| 1 | 5509 | 900 | |
| 2 | 4300 | 600 | |
| 3 | 600 | 2400 | |
| 4 | 1200 | 2100 | |
| 5 | 5509 | 1200 | |
| 6 | 2400 | 2100 | |
| 7 | 3700 | 600 | |
| 8 | 2500 | 600 | |
| 9 | 2400 | 1200 | |

| Door Schedule | | | |
|---------------|--------|-------|----------|
| Mark | Height | Width | Comments |
| 1 | 2076 | 782 | |
| 2 | 2066 | 862 | |
| 3 | 2050 | 756 | |
| 4 | 2066 | 1242 | |
| 5 | 2076 | 1503 | |
| 6 | 2076 | 1703 | |
| 7 | 2100 | 1500 | |
| 8 | 2715 | 2484 | |
| 9 | 2100 | 2410 | |
| 10 | 2100 | 1500 | |
| | | | |

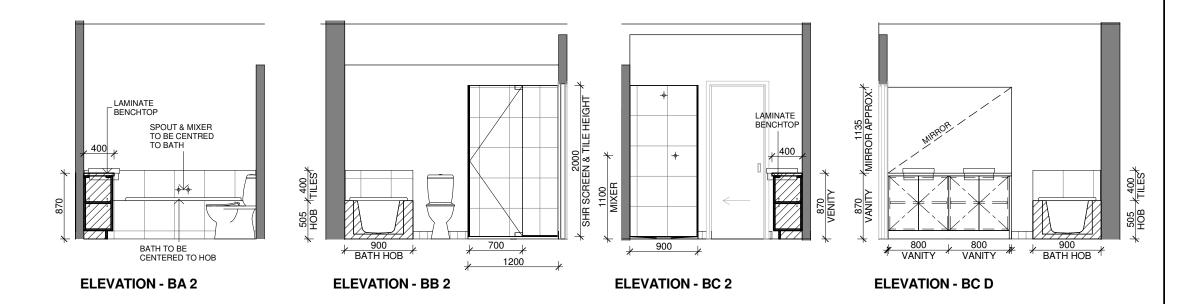
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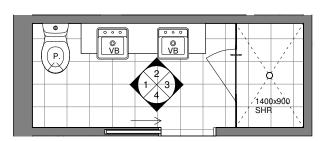




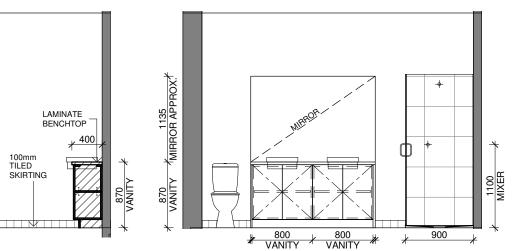


UNIT 2,3,4 BATH PLAN SCALE 1:50

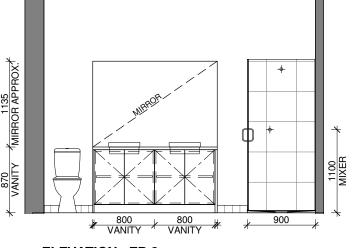




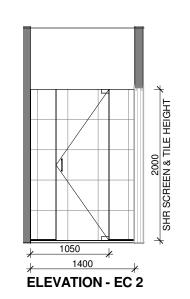
UNIT 2,3,4 ENSUITE PLAN SCALE 1:50

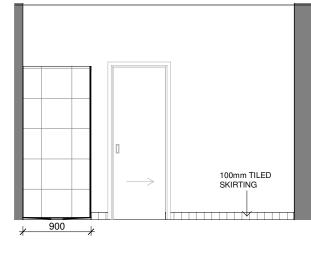


ELEVATION - EA 2



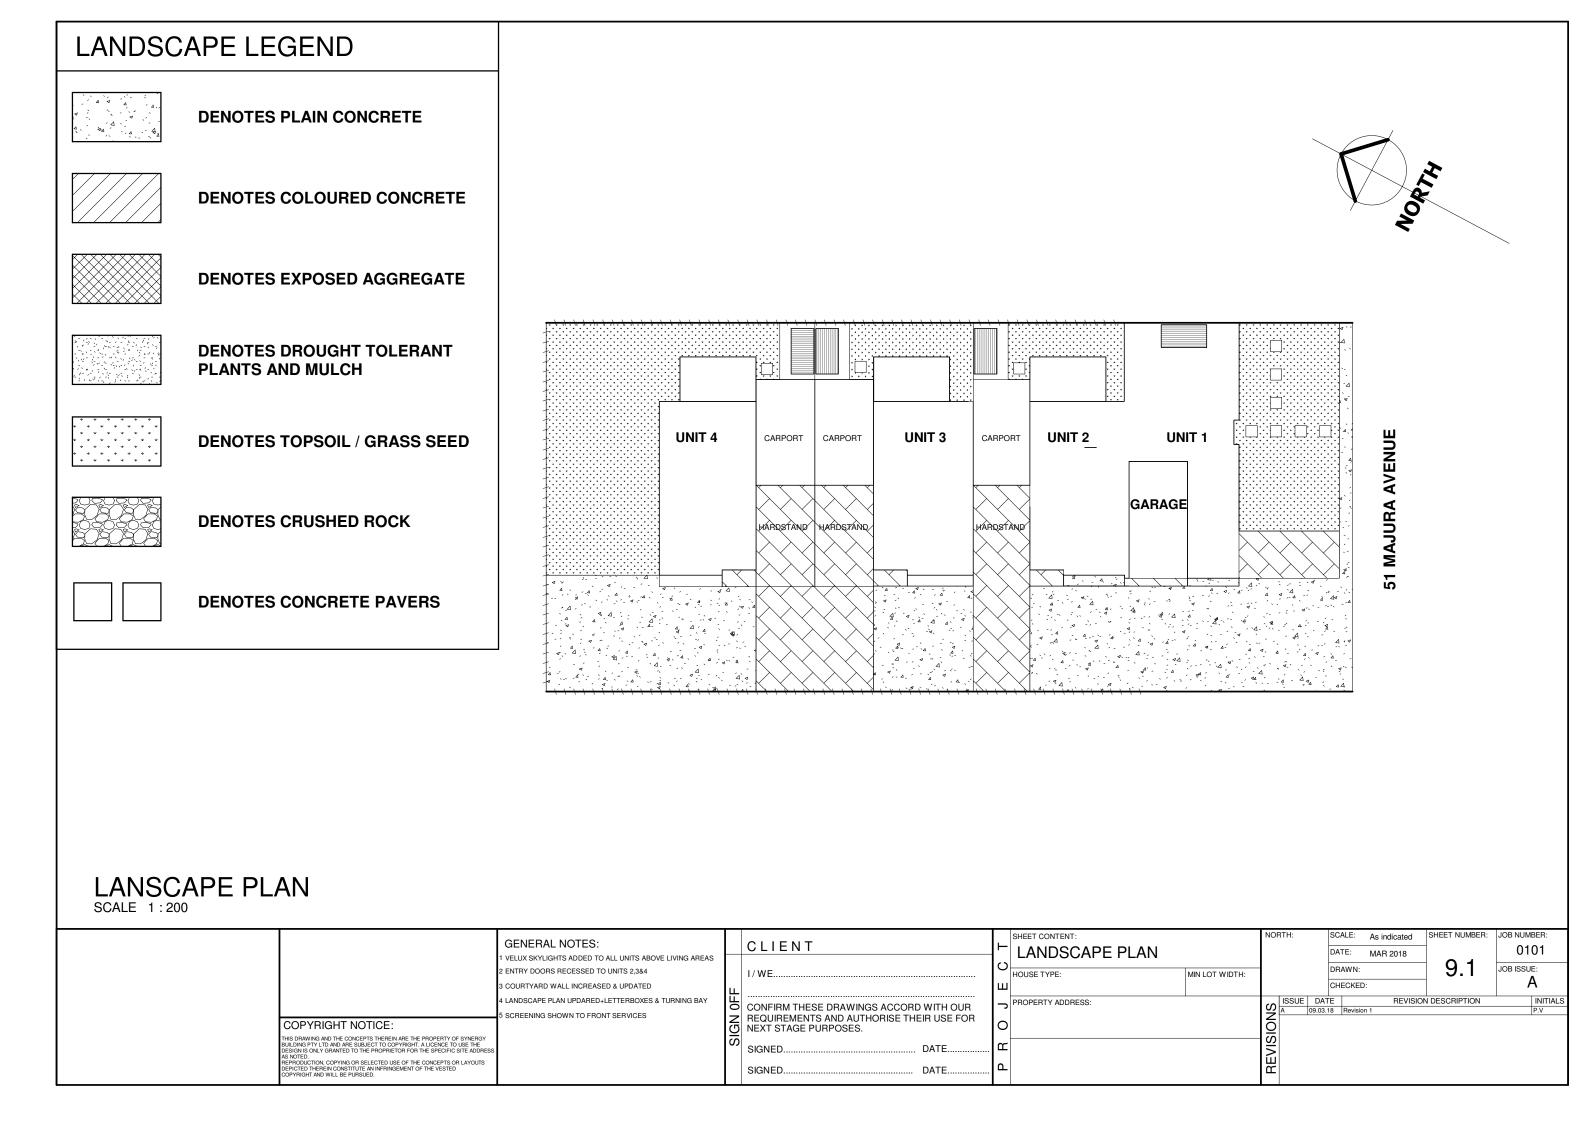
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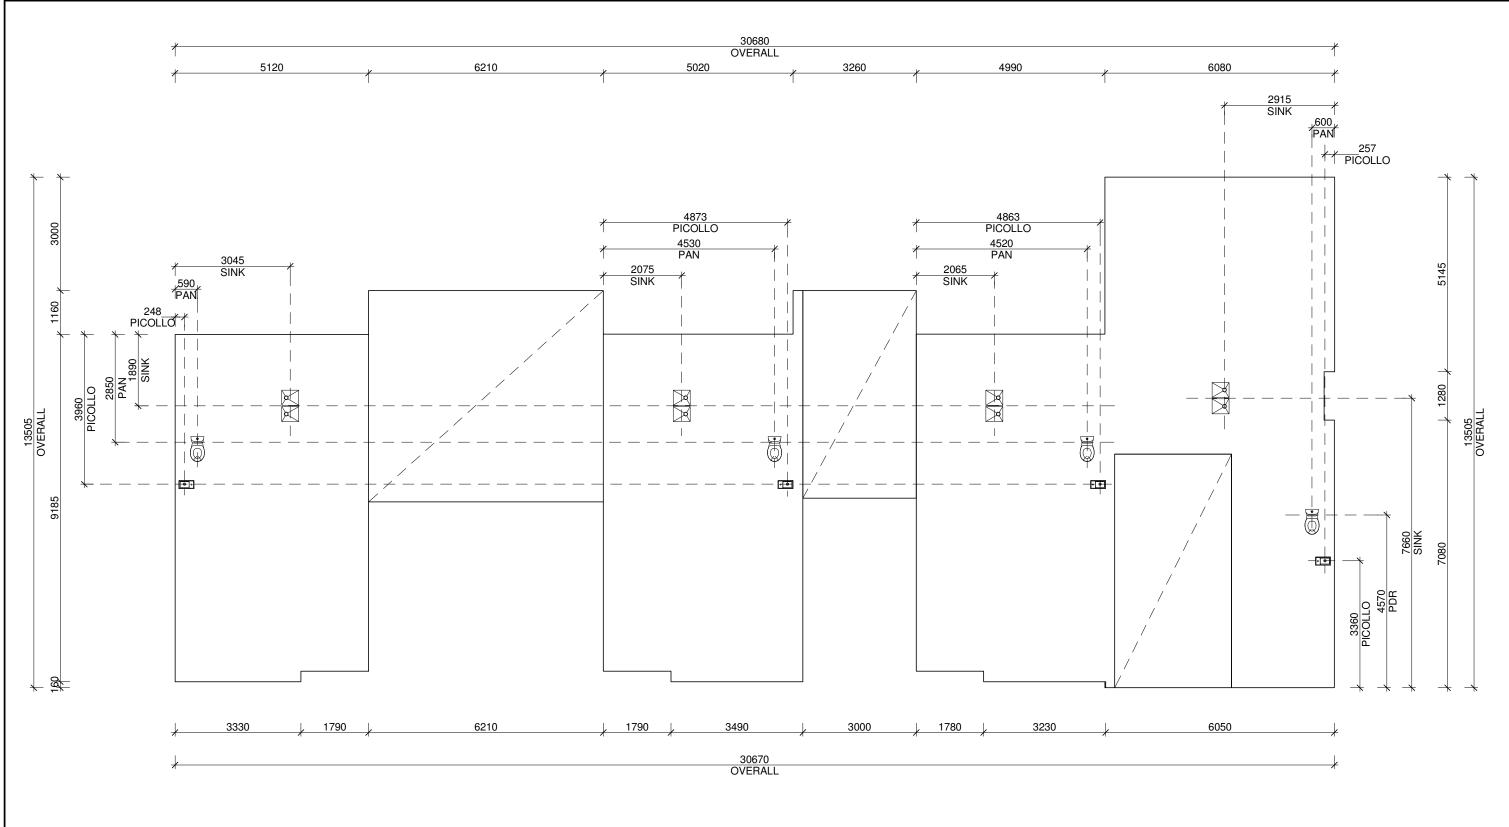




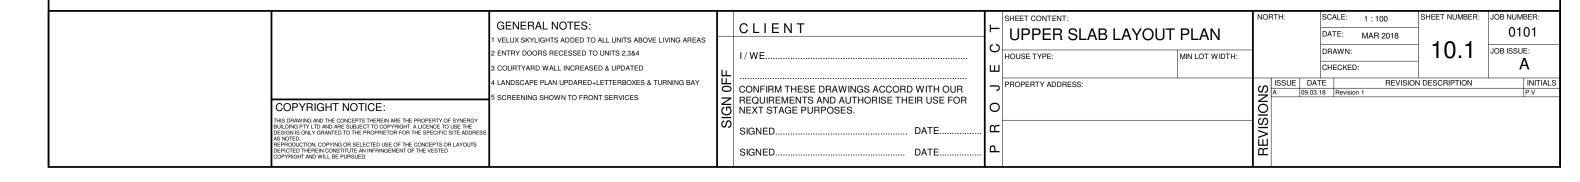
ELEVATION - ED 2

| GENERAL NOTES: 1 VELUX SKYLIGHTS ADDED TO ALL UNITS ABOVE LIVING AREA 2 ENTRY DOORS RECESSED TO UNITS 2,3&4 3 COURTYARD WALL INCREASED & UPDATED 4 LANDSCAPE PLAN UPDARED+LETTERBOXES & TURNING BAY 5 SCREENING SHOWN TO FRONT SERVICES THIS DRAWING AND THE CONCEPTS THEREIN ARE THE PROPERTY OF SYNERGY BUILDING PTY LTD AND ARE SUBJECT TO COPYRIGHT. A LICENCE TO USE THE DESIGNS ONLY GRANTED TO THE PROPHETOR FOR THE SPECIFIC SITE ADDRESS AS BOOK OF THE PROPHETOR OF THE SPECIFIC SITE ADDRESS AS BOOK OF THE PROPHETOR OF THE SPECIFIC SITE ADDRESS AS BOOK OF THE PROPHETOR OF THE SPECIFIC SITE ADDRESS AS BOOK OF THE PROPHETOR OF THE SPECIFIC SITE ADDRESS AS BOOK OF THE PROPHETOR OF THE SPECIFIC SITE ADDRESS AS BOOK OF THE PROPHETOR OF THE SPECIFIC SITE ADDRESS AS BOOK OF THE PROPHETOR OF THE SPECIFIC SITE ADDRESS AS BOOK OF THE PROPHETOR AND THE ADDRESS OF THE CONCEPTS OR LAYOUTS DEPICTED THERE IN CORNER OF THE VESTED LAYOUTS | CLIENT I/WE CONFIRM THESE DRAWINGS ACCORD WITH OUR REQUIREMENTS AND AUTHORISE THEIR USE FOR NEXT STAGE PURPOSES. SIGNED | SHEET CONTENT: BATH&ENSUITE HOUSE TYPE: MIN LOT WIDTH: PROPERTY ADDRESS: O | DATE: MAR 2018 | 8.3 JOB NUMBER: 0101 JOB ISSUE: A SCRIPTION INITIALS P.V |
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SLAB LAYOUT PLAN SCALE 1:100



THANK YOU